

PROTECT IN PLACE KEYNOTES

PROTECT IN PLACE EXISTING CONCRETE CURB, PERIMETER FENCE, AND GATES.

PROTECT IN PLACE EXISTING ASPHALT PAVEMENT.

PROTECT IN PLACE EXISTING BLEACHERS, STAIRS AND RAMPS.

PROTECT IN PLACE EXISTING DOMESTIC WATER LINE.

PROTECT IN PLACE EXISTING STORMWATER DRAIN LINE.

PROTECT IN PLACE EXISTING ELECTRICAL SLEEVING AND LEADS.

DEMOLITION KEYNOTES

REMOVE AND DISPOSE OF EXISTING TRACK SURFACING, ASPHALT AND AGGREGATE BASE SECTION. REFER TO GEOTECHNICAL REPORT FOR SUBGRADE REQUIREMENTS AND APPROXIMATE DEPTH.

REMOVE AND DISPOSE OF EXISTING SYNTHETIC TURF, PERMEABLE BASE AND FLAT DRAINS. REFER TO GEOTECHNICAL REPORT FOR ADDITIONAL REQUIREMENTS & APPROXIMATE DEPTH.

REMOVE AND DISPOSE OF EXISTING CONCRETE CURB.

REMOVE AND DISPOSE OF EXITING SLOTTED DRAIN AND CONCRETE ENCASEMENT.

REMOVED AND DISPOSE OF EXISTING CONCRETE JUMP PIT CURBS AND PIT

REMOVE AND DISPOSE OF EXISTING DRAIN INLETS, DRAIN PIPE, DRAIN ROCK & FABRIC WITHIN PROJECT LIMITS.

REMOVE AND DISPOSE OF EXISTING ELECTRICAL BOXES. PROTECT EXISTING CONDUIT AND ELECTRICAL LEADS IN PLACE TO RECEIVE NEW BOXES.

REMOVE AND DISPOSE OF ALL EXISTING IRRIGATION OR DRAINAGE PIPES. WITHIN THE CONSTRUCTION LIMITS. THE CONTRACTOR MUST VERIFY ALL EXISTING IRRIGATION AND/OR DRAINAGE SOURCES. CONTRACTOR IS RESPONSIBLE TO MAINTAÍN BOTH FLOW AND AUTOMATED CONTROL SERVICE TO ANY ADJACENT LANDSCAPE OR DRAINAGE AREAS DURING AND AFTER


REMOVE AND DISPOSE OF EXISTING POLE VAULT TRACK SURFACE WHILE PROTECTING EXISTING ASPHALT IN PLACE.

OF EXISTING FOOTBALL GOAL POSTS AND FOOTINGS. REMOVE AND DISPOSE OF EXISTING TRACK LANE GATES.

TOTAL DISTURBED AREA

TOTAL DISTURBED AREA = 3.6 ACRES

LEGEND

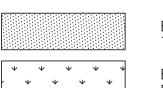

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EXISTING TRACK SURFACE AND ASPHALT BASE TO BE REMOVED

GRADE BREAK

WROUGHT-IRON FENCE

WATER FOUNTAIN

WATER METER

WATER VALVE

EXISTING SYNTHETIC TURF PLAYING FIELD AND BASE TO BE REMOVED

DESCRIPTION FENCE LINE BUILDING LINE UNDERGROUND ELECTRICAL

UNDERGROUND IRRIGATION UNDERGROUND JOINT UTILITIES UNDERGROUND WATER UNDERGROUND UNKNOWN UNDERGROUND SANITARY SEWER UNDERGROUND STORM SEWER

FLOW LINE

FLAG POLE

G HNG GATE HINGE

G LTCH GATE LATCH

ABBREVIATIONS

ASPHALT CONCRETE AREA DRAIN GROUND ELEVATION AREA LIGHT JOINT POLE BUILDING CORNER IRRIGATION CONTROL VALVE BACK OF WALK BOLLARD MANHOLE BACKFLOW PREVENTER PARKING STRIPE BUILDING LINE RPS RUBBERIZED PLAY SURFACE CATCH BASIN RETAINING WALL CHAIN-LINK FENCE RWLS RAINWATER LEADER SURFACE RELEASE CONCRETE RWLUG RAINWATER LEADER UNDERGROUND RELEASE C BOX COMMUNICATIONS BOX S BOX SIGNAL BOX COL COLUMN STORM DRAIN EDGE OF CONCRETE STREET LIGHT EDGE OF PAVEMENT SANITARY SEWER EDGE OF TRACK SANITARY SEWER CLEANOUT E BOX ELECTRICAL BOX TOP OF CURB ELECTRICAL PULL BOX TELEPHONE VAULT FINISHED FLOOR ELEVATION


GENERAL DEMOLITION NOTES

- 1. THE CONTRACTOR SHALL VISIT THE SITE PRIOR TO BID SUBMITTAL IN ORDER TO DETERMINE THE EXTENT AND CONDITIONS OF SITE DEMOLITION AND TO FIELD VERIFY SITE CONDITIONS. THE CONTRACTOR SHALL NOTIFY THE OWNER OF ANY DISCREPANCIES PRIOR TO BID.
- 2. THE CONTRACTOR SHALL PERFORM ALL CLEARING, DEMOLITION AND REMOVAL SITE PREPARATIONS NECESSARY FOR THE EXECUTION OF THE WORK CONTAINED IN THE CONTRACT DOCUMENTS.
- 3. EXISTING STORM DRAIN FACILITIES WITHIN THE LIMITS OF CONSTRUCTION SHALL BE PROTECTED FROM CONSTRUCTION DEBRIS INTRUSION. THE CONTRACTOR SHALL FLUSH AND CLEAN EXISTING DRAINAGE SYSTEMS THAT ARE TO BE PROTECTED IN PLACE, WITHIN THE PROJECT LIMITS, TO THE POINT OF DISCHARGE. ALL CLEAN OF SITE AND DRAINAGE SYSTEMS SHALL MEET ALL CALIFORNIA SAFETY AND WATER QUALITY REQUIREMENTS SET BY THE STATE BOARD OF WATER RESOURCES.
- 4. THE CONTRACTOR SHALL VERIFY THE LOCATIONS OF ALL UTILITIES, STRUCTURES, AND SERVICES BEFORE COMMENCING WORK. CONTRACTOR IS RESPONSIBLE FOR POT-HOLING AND UTILITY SURVEYS AS NECESSARY TO LOCATE EXISTING UTILITIES.
- 5. THE CONTRACTOR SHALL PROVIDE ALL NECESSARY BMP's AND PROTECTIONS TO DRAINS AND DRAINAGE SYSTEMS AS REQUIRED BY THE PROJECT SWPPP DOCUMENTS AND CALIFORNIA STATE WATER RESOURCES CONTROL BOARD PRIOR TO COMMENCING DEMOLITION.
- 6. CONTRACTOR SHALL BE RESPONSIBLE FOR REPAIRING OR REPLACING ANY EXISTING ITEM DAMAGED OR DESTROYED BY CONSTRUCTION NOT IDENTIFIED FOR DEMOLITION OR REMOVAL. REPLACEMENT OR REPAIRS SHALL BE AT THE CONTRACTOR'S EXPENSE AND ITEM RESTORED TO EQUAL OR BETTER CONDITION.
- 7. THE CONTRACTOR SHALL PROVIDED NECESSARY MEASURES TO CONTROL DUST AND ARBOR SEDIMENT PER PER THE SWPPP DOCUMENTS AND AS REQUIRED BY THE STATE.
- 8. REFER TO AS-BUILT DRAWINGS AND GEOTECHNICAL REPORT FOR DEPTH OF EXISTING PAVING AND BASES.
- 9. CONTRACTOR MUST REMOVE AND DISPOSE OF ALL WEEDS, LOOSE MATERIALS.
- 10. THE CONTRACTOR SHALL OBTAIN ANY REQUIRED PERMITS PRIOR TO
- 11. CONTRACTOR IS RESPONSIBLE FOR MAINTAINING IRRIGATION SERVICE TO EXISTING LANDSCAPE MATERIAL TO REMAIN AND TO ADJACENT FIELDS BOTH DURING AND AFTER CONSTRUCTION.
- 12. THE CONTRACTOR MUST CONTACT LOCAL UTILITY LOCATION SERVICES PRIOR TO CONSTRUCTION.
- 13. THE CONTRACTOR MUST PROTECT IN PLACE ALL EXISTING UTILITIES.
- 14. THE CONTRACTOR IS RESPONSIBLE FOR REPAIR OR REPLACEMENT OF UTILITIES DAMAGED DURING CONSTRUCTION.
- 15. REFER TO SPECIFICATIONS FOR ADDITIONAL INFORMATION REGARDING DEMOLITION.
- 16. CONTRACTOR SHALL NOTIFY USA 800-227-2600 PRIOR TO ANY DEMOLITION OR EXCAVATION.
- 17. CONTRACTOR SHALL PROVIDE CONSTRUCTION FENCING PLAN SUBMITTAL FOR REVIEW AND APPROVAL PRIOR TO CONSTRUCTION. CONTRACTOR SHALL MAINTAIN STUDENT ACCESS TO THE CONCESSIONS BUILDING AND BASEBALL FIELD WITH A MINIMUM 6' WIDE PAVED PATH SOUTH OF THE TRACK. THE ACCESS WILL EXTEND FROM THE EXISTING STADIUM ENTRY TO THE VISITOR'S BLEACHERS.



SUITE 515-324 SCOTTSDALE, ARIZONA 85258 PH 602.635.4226 FAX 602.997.3148



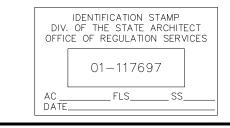

DSA BACK CHECK	<
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 $\sqrt{3}$ ADDENDA 3 11/27/2018

SANTA TERESA HIGH SCHOOL

6150 Snell Avenue San Jose, CA

TRACK & FIELD RENOVATION


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PROJ. 18-115 APPROVED:

DEMOLITION PLAN

DWG. NO. **TF-03**

SCALE: 1" = 30'

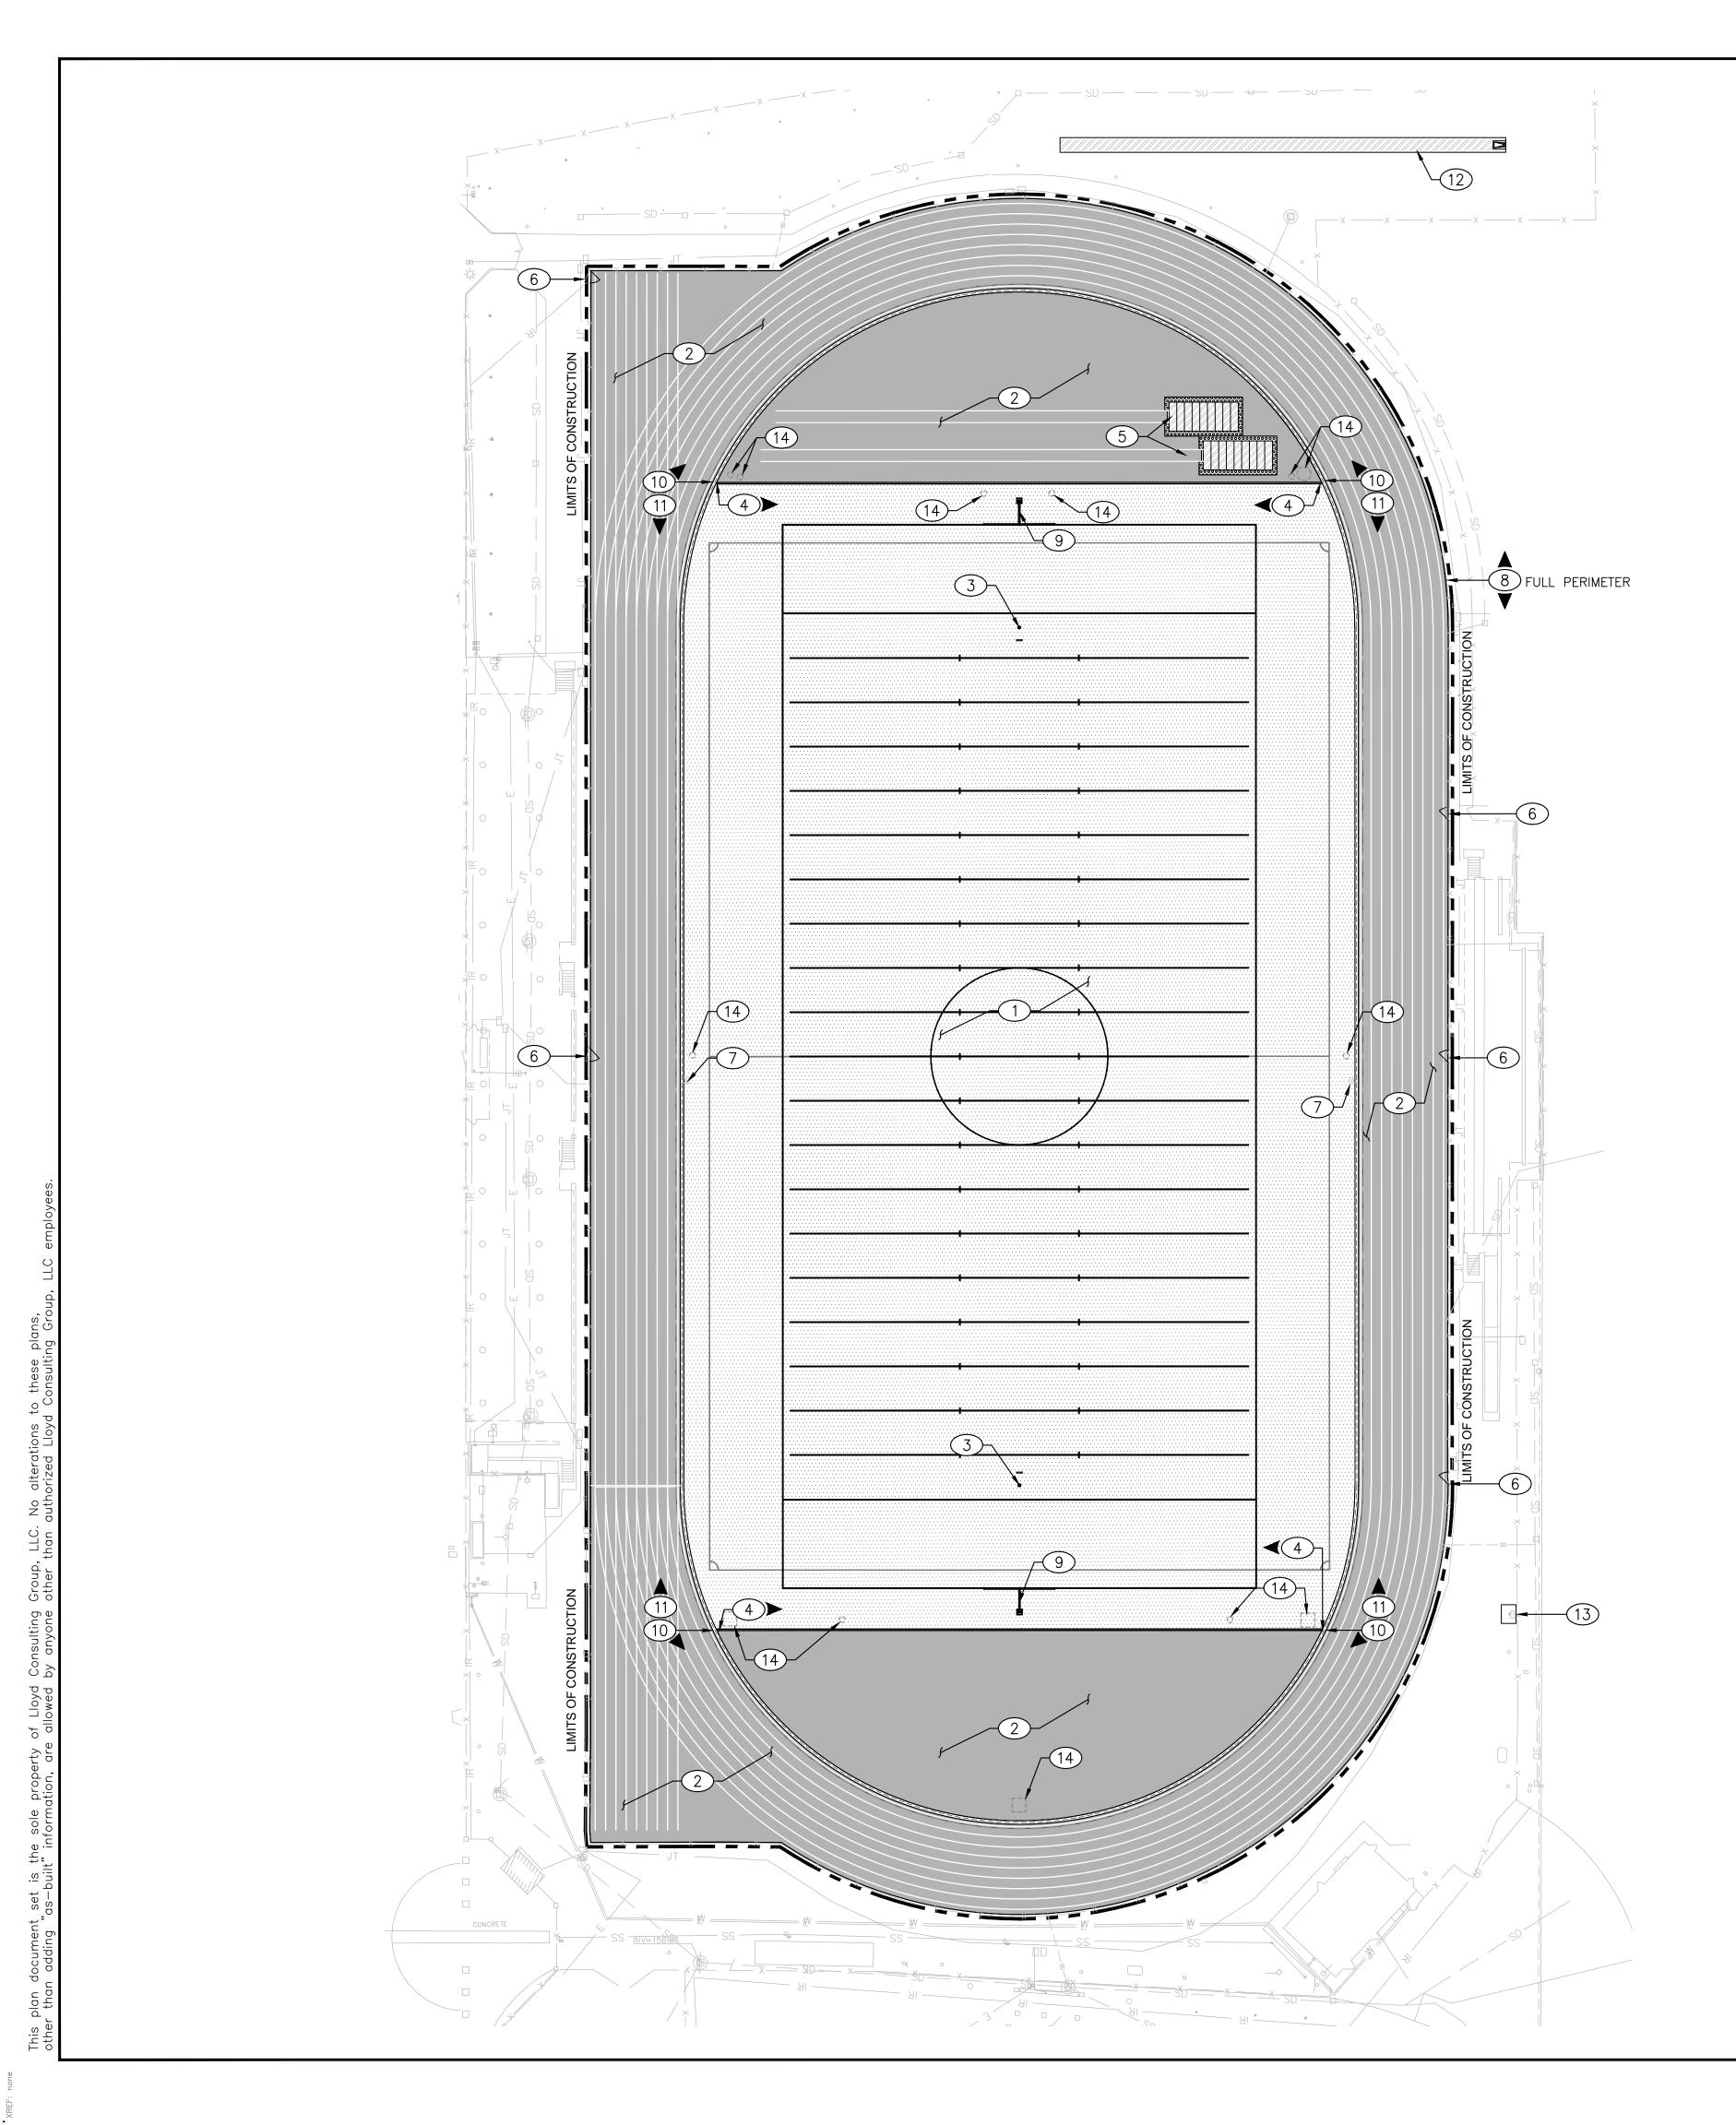

GENERAL NOTES:

- 1. ALL COMPETITION REQUIRED STRIPES AND MARKINGS MUST BE INLAID AND MUST MEET THE LATEST REQUIREMENTS OF NFHS FOOTBALL AND SOCCER RULES. FOOTBALL MARKINGS TO BE WHITE, SOCCER MARKINGS TO BE YELLOW.
- 2. GENERAL CONTRACTOR IS RESPONSIBLE FOR PREPARATION OF THE BASE IN THE TURF AREAS AND FOR COORDINATION WITH THE TURF INSTALLER'S WORK. TURF INSTALLER MUST SUBMIT COMPLETE SHOP DRAWINGS AND COLOR SAMPLES FOR REVIEW AND APPROVAL PRIOR TO INSTALLATION OF SYNTHETIC TURF. SUBMITTALS FOR SHOP DRAWINGS AND COLOR SAMPLES MUST BE IN ACCORDANCE WITH THE SPECIFICATIONS.
- 3. THE OWNER (OR ITS REPRESENTATIVE) MUST REVIEW AND APPROVE THE FONTS USED FOR YARD LINE NUMBERING, ENDZONE LETTERING, AND TRACK MARKINGS PRIOR TO INSTALLATION OF THE SYNTHETIC TURF OR STRIPING OF THE TRACK.

SURFACING KEY NOTES:


- INSTALL SYNTHETIC TURF SYSTEM, SHOCK/DRAIN PAD AND PERMEABLE BASE PER DETAIL 01 ON SHEET TF-10.1
- INSTALL ASPHALT PAVING W/ RUBBERIZED SURFACE PER DETAIL 02 AND 05 ON SHEET TF-10.1.
- INSTALL TRACK RADIUS MONUMENT POINT PER DETAIL 04 ON SHEET
- INSTALL 6" WIDE CONCRETE INSIDE TRACK CURB PER DETAIL 03 AND 05 ON SHEET TF-10.1.
- INSTALL LONG/TRIPLE JUMP & LANDING PIT SYSTEM PER DETAIL 06 ON SHEET TF-10.1. PIT COVERS TO RECEIVE TRACK SURFACING.
- REPAIR GATES AND INSTALL ACCESSIBLE HARDWARE AS NEEDED, SEE DETAIL 03 ON SHEET TF-10.3.
- INSTALL COMBOX IN SYNTHETIC TURF PER DETAIL 09 ON SHEET REPAIR EXISTING FENCE POSTS AS NEEDED. CLEAN, PRIME AND PAINT POSTS. INSTALL NEW VINYL CLAD RAILS & FABRIC. (COLOR BLACK) REFER TO SPECIFICATIONS.
- INSTALL FOOTBALL GOAL POSTS PER DETAIL 10, SHEET TF-10.1 & SPECIFICATIONS.
- TF10.1. REFER TO DRAINAGE PLAN FOR LOCATIONS OF CATCH BASINS AND DRAIN PIPE CONNECTIONS.

INSTALL SLOTTED DRAIN AT SYNTHETIC TURF PER DETAIL 08 ON

- INSTALL RUBBERIZED SURFACE OVER EXISTING ASPHALT PER SPECIFICATIONS.
- ACCESSIBLE DRINKING FOUNTAIN, PER DETAIL 06 ON SHEET TF-10.2.
- STORM DRAIN STRUCTURE, SEE DRAINAGE PLAN SHEET TF-06. 14

SURFACING LEGEND

PERMEABLE & SYNTHETIC TURF SYSTEM.

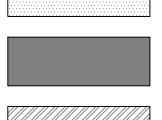

NEW ASPHALT PAVING W/ RUBBERIZED SURFACE.



SYNTHETIC TRACK SURFACE OVER EXISTING ASPHALT OR PIT COVER.




KEYNOTE CALLOUT SYMBOL



SUITE 515-324 SCOTTSDALE, ARIZONA 85258 PH 602.635.4226 FAX 602.997.3148



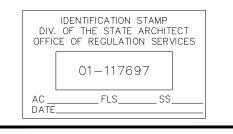

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3 ADDENDA 3 11/27/2018

SANTA TERESA HIGH SCHOOL TRACK & FIELD RENOVATION


6150 Snell Avenue San Jose, CA

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APPROVED: SURFACING PLAN

DWG. NO.

TF-04

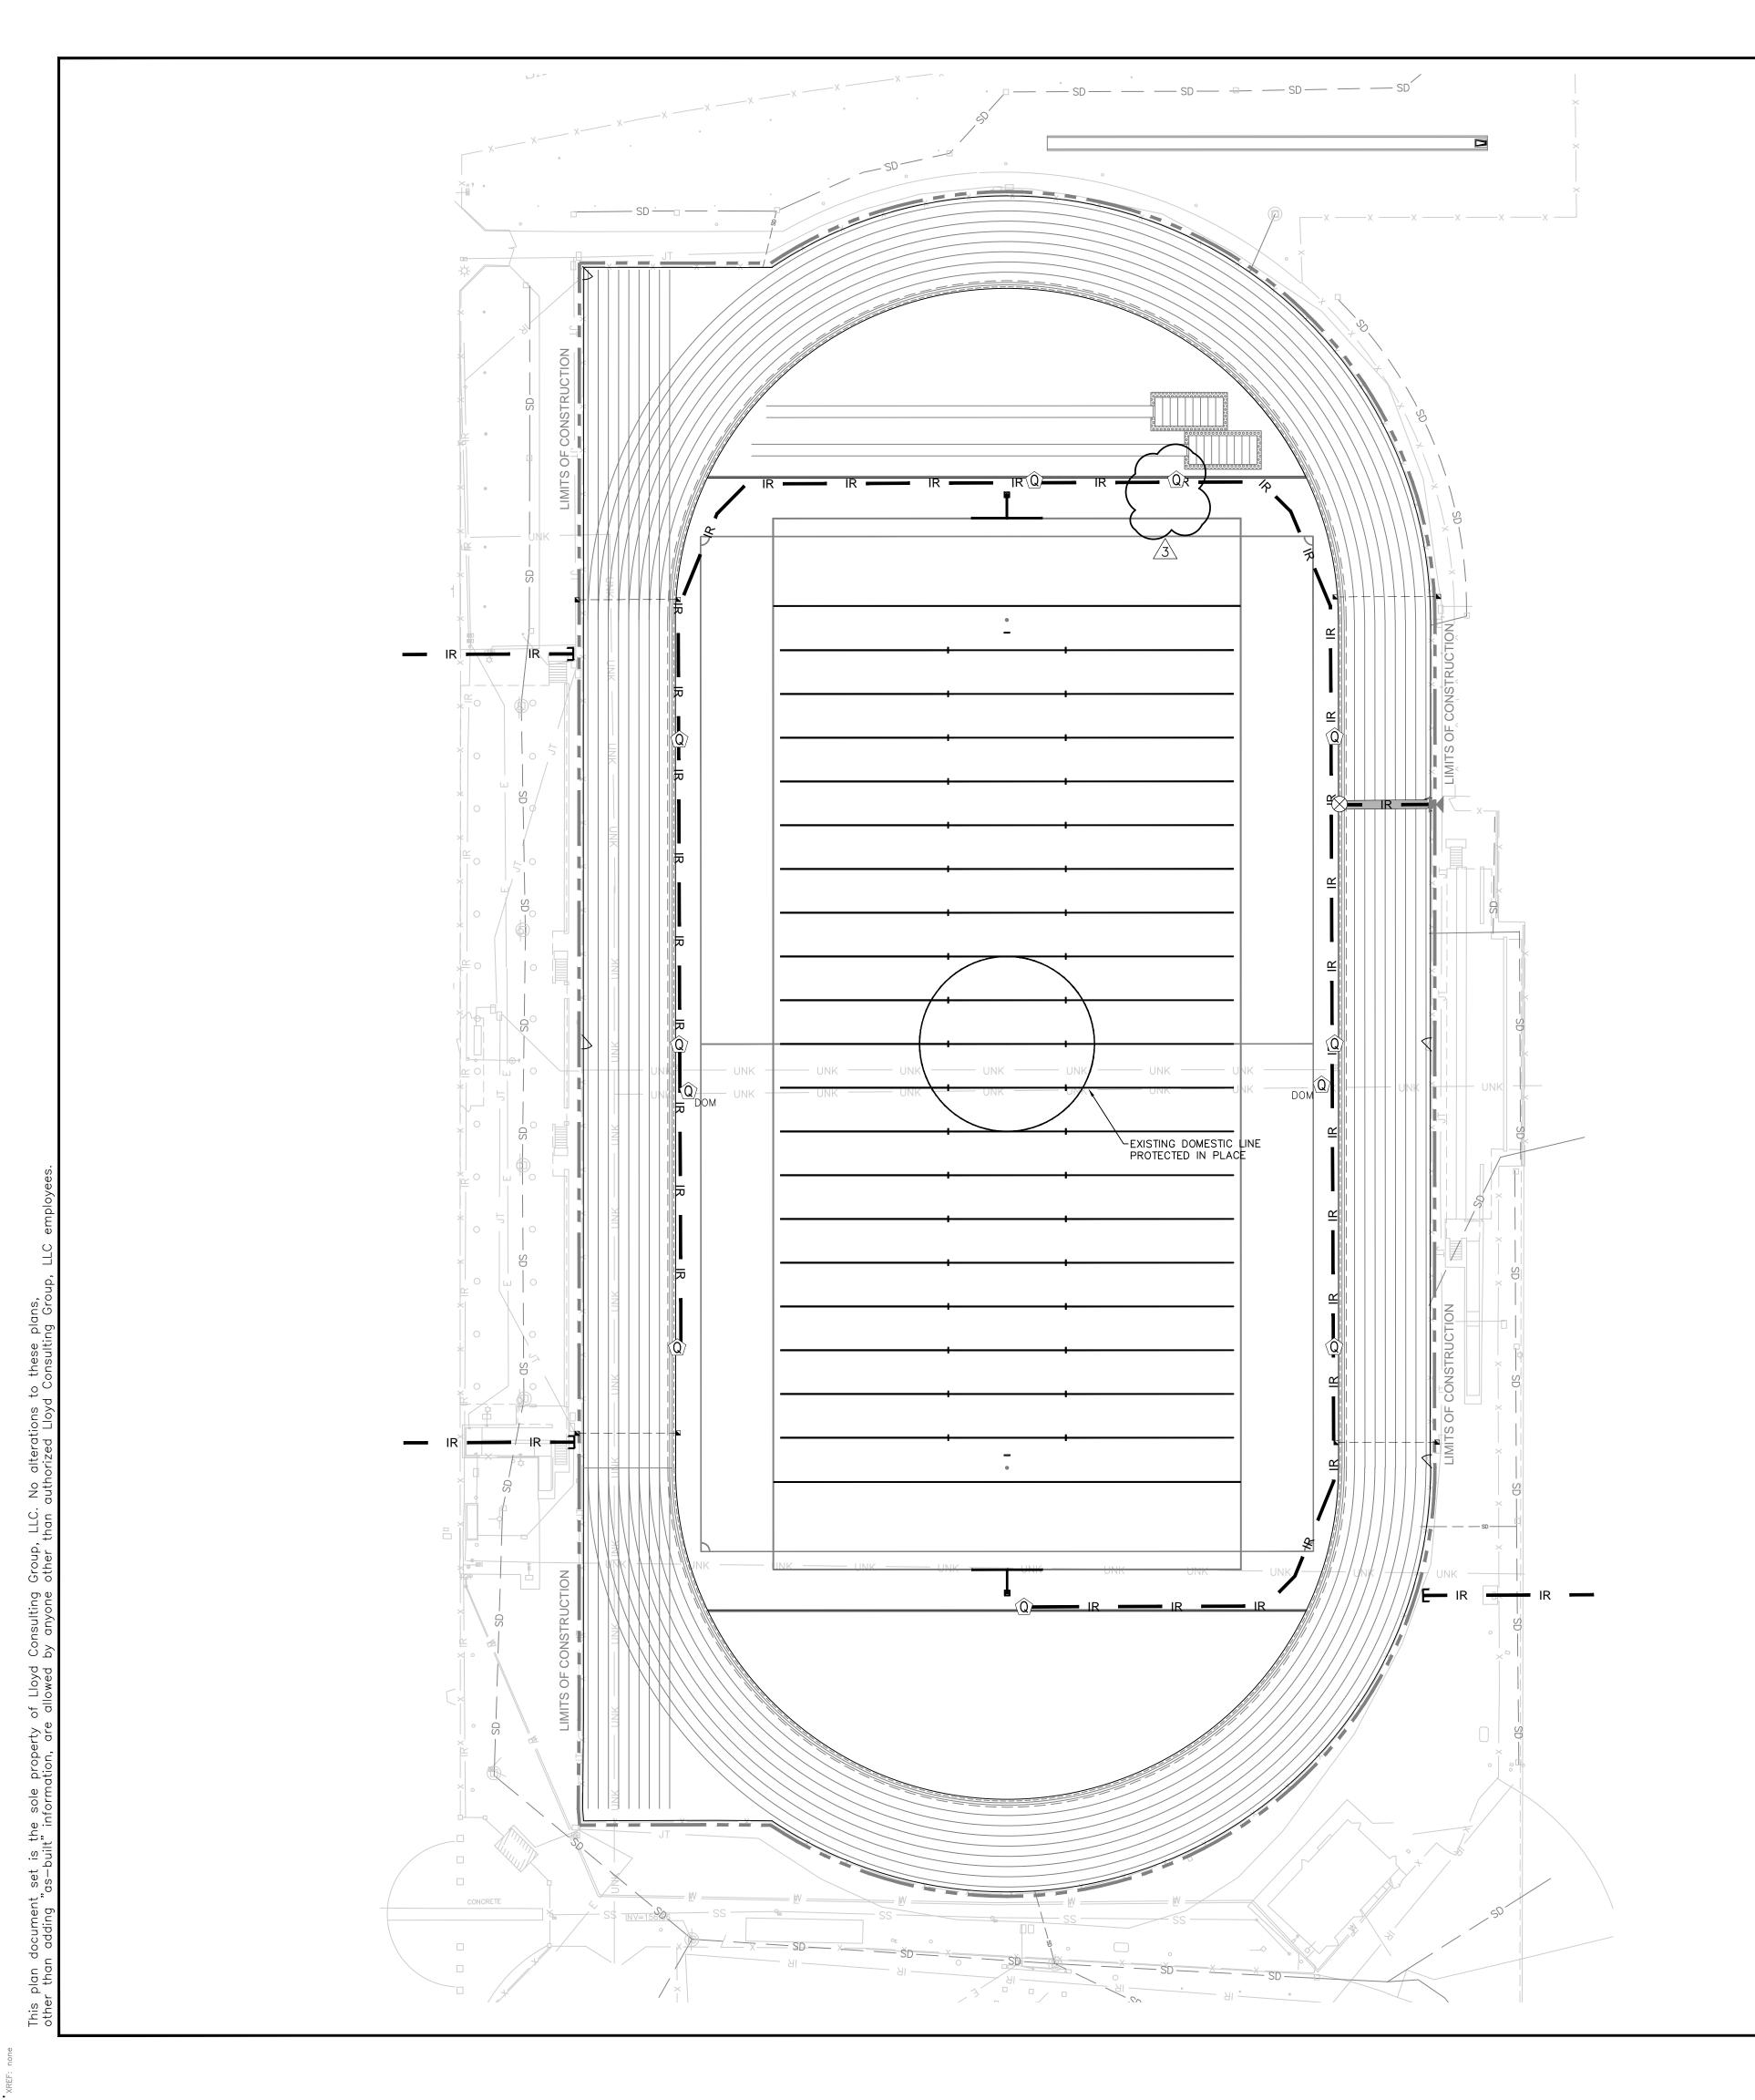

IRRIGATION EQUIPMENT LEGEND:

CONNECT TO EXISTING IRRIGATION MAINLINE

CUT AND CAP EXISTING MAINLINE AT APPROXIMATE LOCATION

IRRIGATION MAINLINE (2" EXCEPT WHERE NOTED OTHERWISE)
SOLVENT WELD CLASS 200 PVC W/ SCH 80 FITTINGS

 \otimes ISOLATION GATE VALVE (SIZE TO MATCH MAINLINE) NIBCO T113-K

QUICK COUPLER VALVE WITH PURPLE CAP (1" SIZE)
RAINBIRD 44-RC IN SYNTHETIC TURF COMBOX

Q 3" DOMESTIC WATER QUICK COUPLER RAIBIRD 3RC IN SYNTHETIC TURF COMBOX

SLEEVE PIPE 2X NOMINAL SIZE OF CARRIER PIPE INSTALL BELOW ALL HARDSCAPE CROSSINGS

REPLACE EXISTING ELECTRICAL & COMM BOXES, SLEEVING AND LEADS AS TO MAINTAIN EXISTING SERVICE TO FIELD.


IRRIGATION NOTES:

- CONNECT TO EXISTING MAINLINE THE APPROXIMATE LOCATION SHOWN. FLOW AND PRESSURE MUST BE VERIFIED BY CONTRACTOR PRIOR TO CONSTRUCTION. IF PRESSURE IS LESS THAN 50 PSI AT 40GPM NOTIFY ENGINEER IMMEDIATELY.
- REFER TO SPECIFICATIONS FOR ALL PRESSURE TESTING AND FLUSHING REQUIREMENTS.
- 3. ALL IRRIGATION VALVE AND PIPE SYMBOL LOCATIONS ARE DIAGRAMMATIC. DO NOT INSTALL IRRIGATION EQUIPMENT IN DIRECT CONFLICT WITH UTILITY, LANDSCAPE, OR HARDSCAPE ELEMENTS. COORDINATE LOCATION OF ALL NEW AND EXISTING UTILITIES PRIOR TO IRRIGATION INSTALLATION. CONTACT ENGINEER IMMEDIATELY IF CONFLICTS ARE LOCATED.
- 4. EXISTING UTILITIES SHOWN ARE FOR REFERENCE ONLY. ADDITIONAL UTILITIES MAY BE PRESENT. CONTRACTOR MUST UTILIZE UTILITY LOCATION SERVICE PRIOR TO CONSTRUCTION AND TRENCH WITH CAUTION. CONTRACTOR IS RESPONSIBLE TO REPAIR OR REPLACE ANY UTILITIES DAMAGED DURING CONSTRUCTION.
- 5. CUT AND CAP ANY ACTIVE IRRIGATION LINES ENTERING THE TRACK AREA. CONTRACTOR MUST AS—BUILT ALL LIVE IRRIGATION LINES FOUND DURING CONSTRUCTION.
- 6. CONTRACTOR IS REQUIRED TO VERIFY THAT FLOW AND AUTOMATIC CONTROL TO ALL LANDSCAPE IRRIGATION SURROUNDING THE TRACK REMAINS FUNCTIONAL DURING AND AFTER CONSTRUCTION.



7349 N. VIA PASEO DEL SUR SUITE 515-324 SCOTTSDALE, ARIZONA 85258 PH 602.635.4226 FAX 602.997.3148



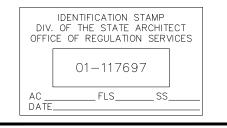

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3 ADDENDA 3 11/27/2018

SANTA TERESA HIGH SCHOOL TRACK & FIELD RENOVATION

6150 Snell Avenue San Jose, CA

SCALE: 1"=30'
DESIGNED:BTL

DATE:10/03/2018

DRAWN: BTL


PROJ. 18-115
APPROVED:

IRRIGATION PLAN

DWG. NO.

TF-09

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COLOR GRAPHICS NOTES:

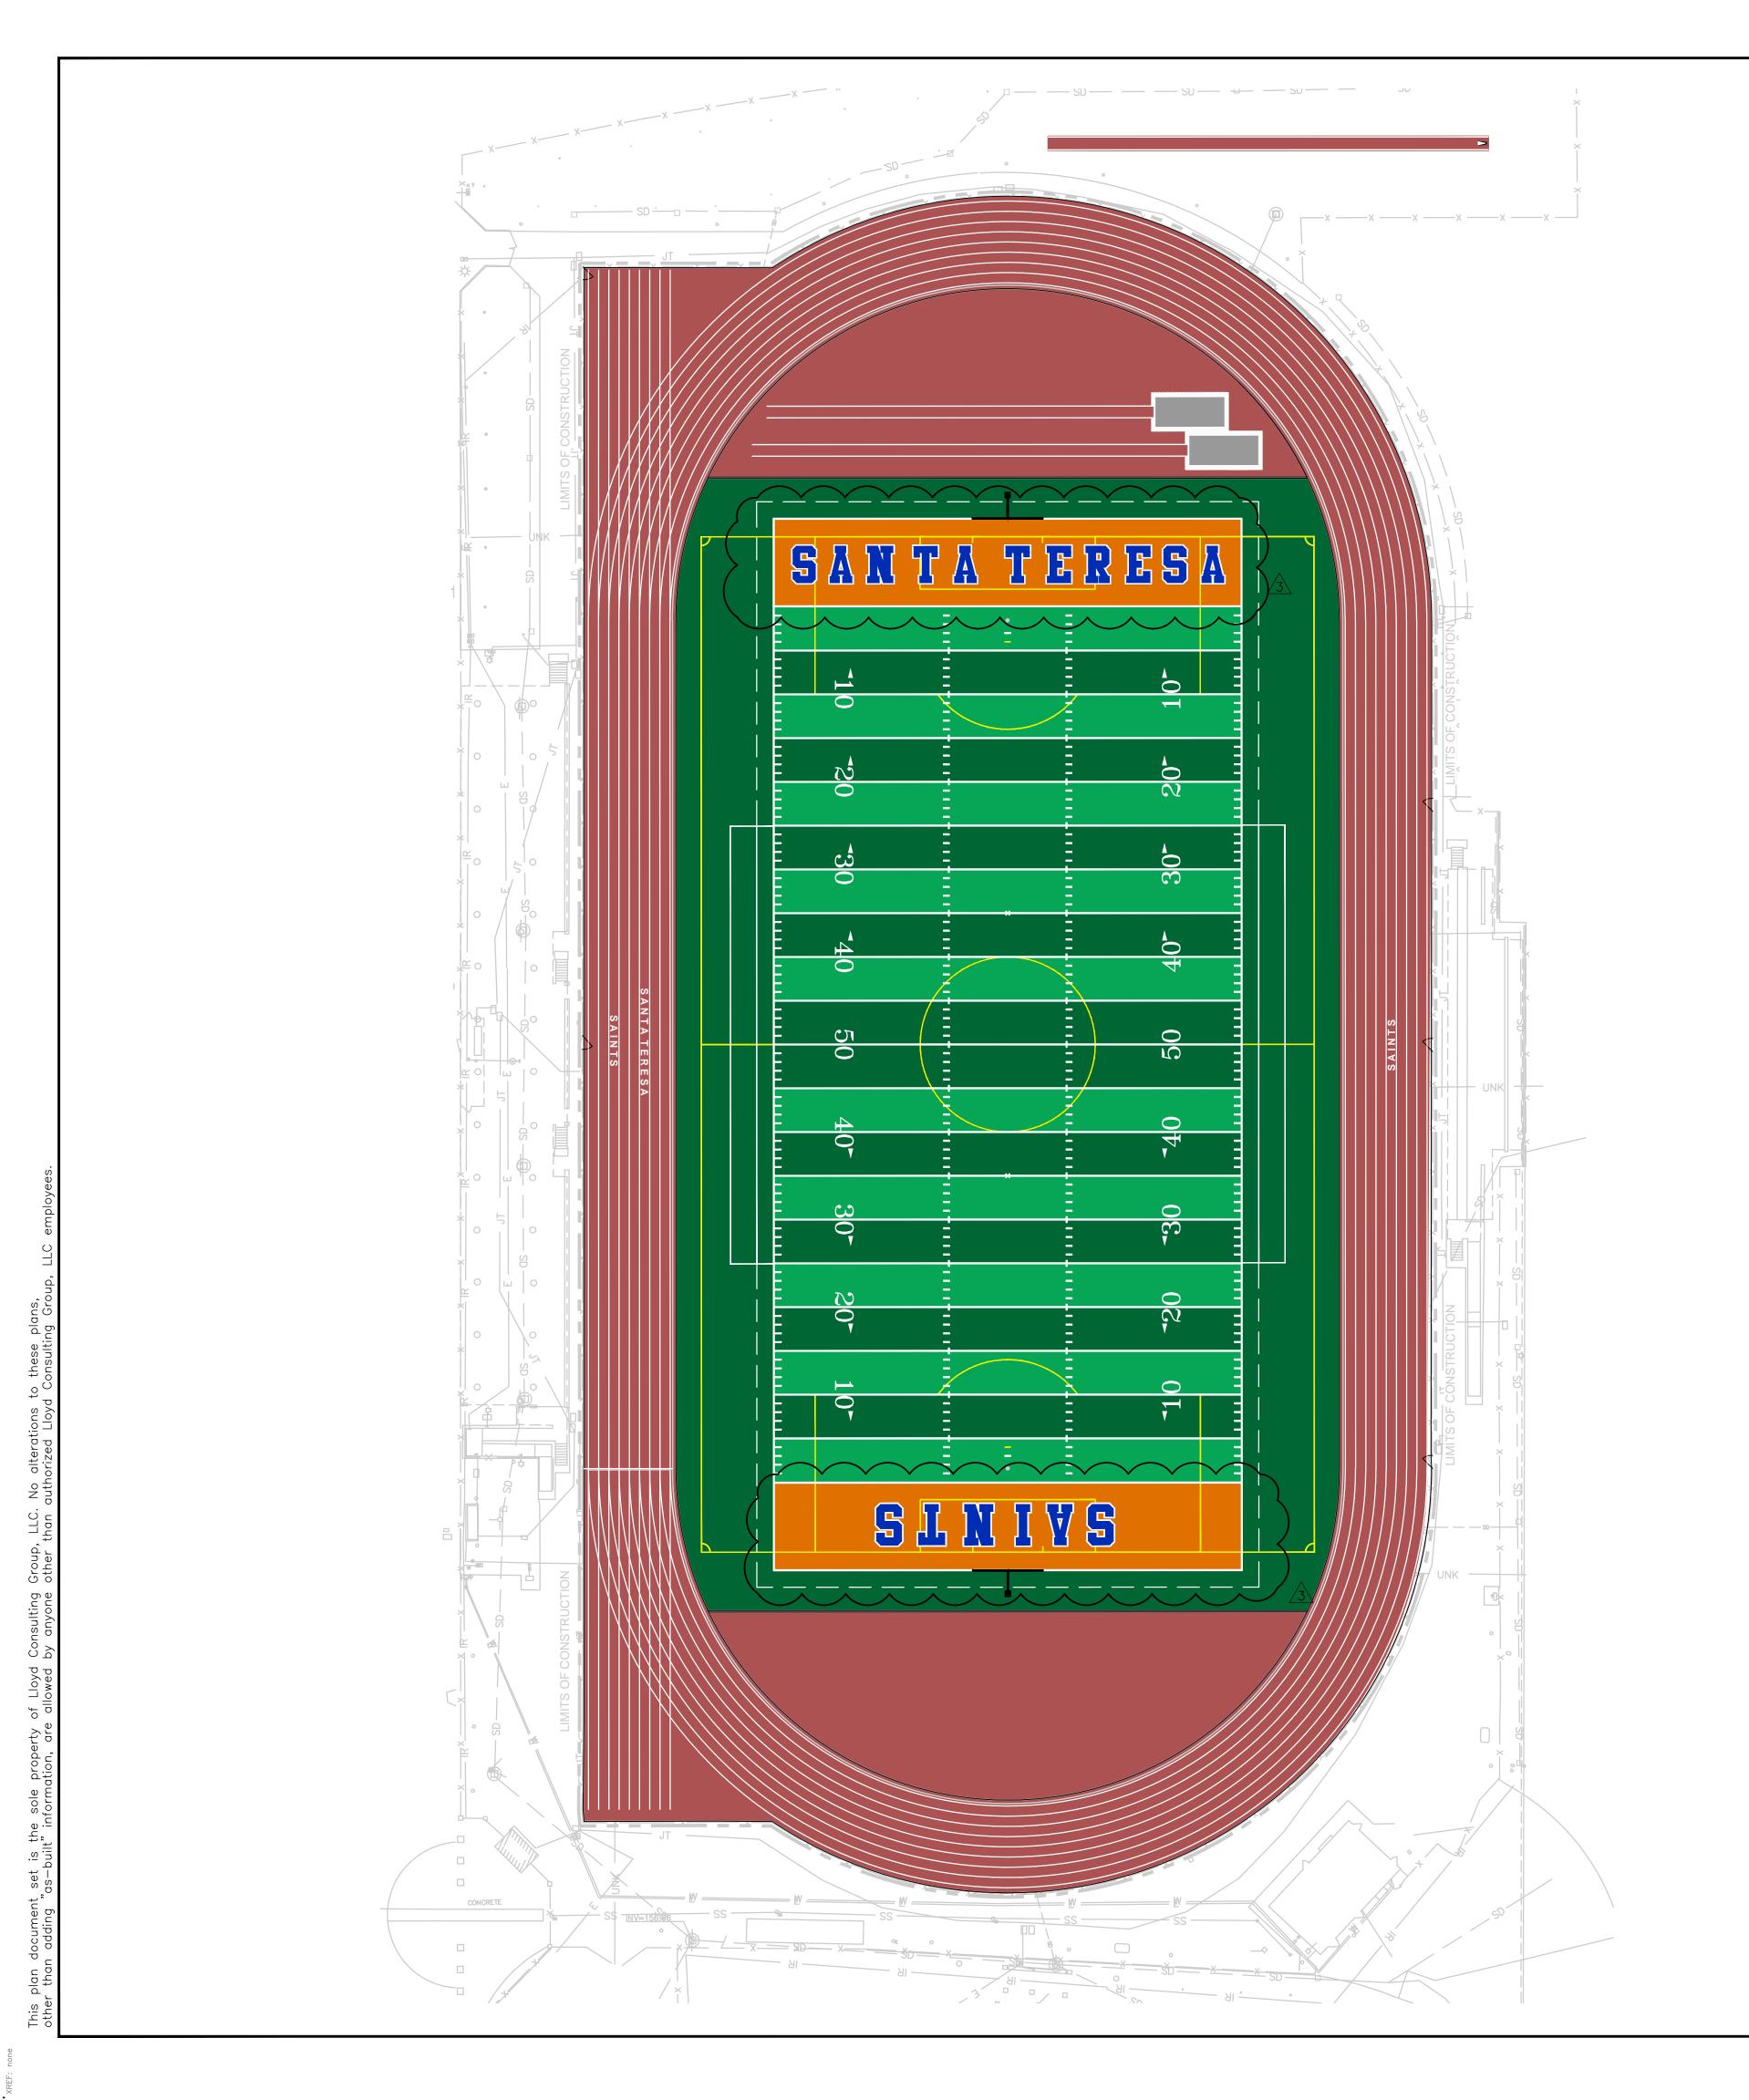
- 1. THIS GRAPHICS PLAN IS FOR REFERENCE ONLY. THE TURF MANUFACTURER AND
- INSTALLER MUST SUBMIT FOR REVIEW SHOP DRAWINGS PER SPECIFICATIONS.


 2. ALL LINE WORK MUST BE IN ACCORDANCE WITH NFHS RULES AND REGULATIONS FOR SOCCER, FOOTBALL AND TRACK AND FIELD.

 3. FOOTBALL IS TO BE THE DOMINATE LINE COLOR OVER SOCCER.

 4. COLOR SELECTION IS TO BE FINALIZED DURING SHOP DRAWING SUBMITTAL REVIEW
- 5. TURF MAY NOT BE PURCHASED UNTIL SHOP DRAWINGS AND PHYSICAL SAMPLES ARE
- APPROVED IN WRITING BY THE OWNER.
- 6. TRACK TO RECEIVE LETTERING ON HOME AND AWAY SIDE PER PLAN.

COLOR GRAPHICS LEGEND

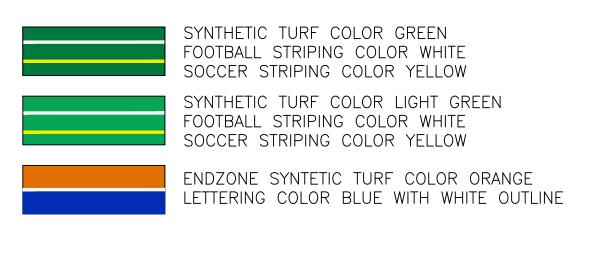

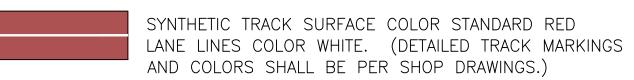




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SANTA TERESA HIGH SCHOOL TRACK & FIELD RENOVATION

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SCALE: 1"=30' DESIGNED:BTL DATE:10/03/2018 DRAWN: BTL PROJ. 18-115

APPROVED:

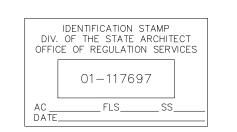DWG. NO. **TF-08**

TURF GRAPHICS PLAN

